

FRONT ELEVATION

SCALE: 1/4" = 1'-0"

CODE & LOADING INFORMATION

OCCUPANCY TYPE

- RESIDENTIAL STORAGE

CONSTRUCTION TYPE

- TYPE 5 B

LOADING NOTES

- 1st FLOOR ON GRADE

- GROUND SNOW = 30 PSF
- DEAD LOADS = 10 PSF
- BASIC WIND SPEED = 115 MPH
- EXPOSURE CLASS = B
- SEISMIC DESIGN CATEGORY = B
- FROST LINE DEPTH = 36" (OR BY LOCAL CODES)
- ASSUMED SOIL CLASS = GM, GC
- SOIL BEARING CAPACITY = 2000 PSF IF SOIL DIFFERS FROM ASSUMED ABOVE (REFER TO IRC CODES)



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PROJECT:

12x20 Wood Pavilion Open Gables

| FINAL | 2/3/22 | E.S. |
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CONCEPTS

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SCALE:


AS NOTED


SHEET TITLE:

Cover sheet

PROJECT NO.:

D851-21

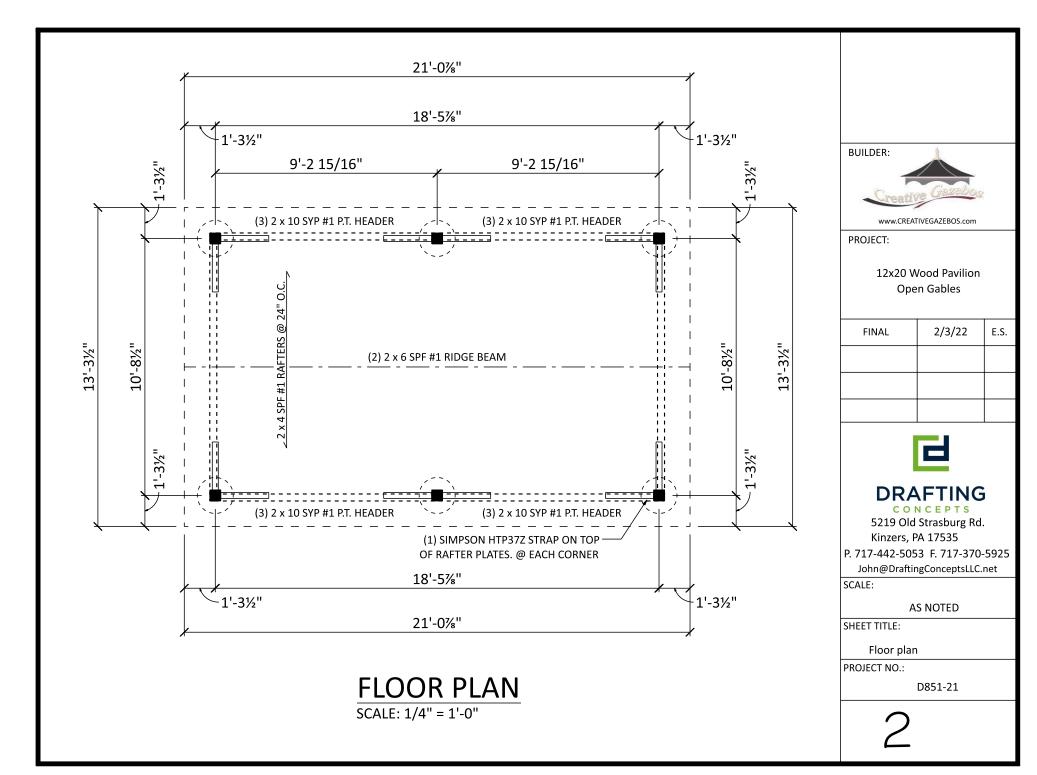

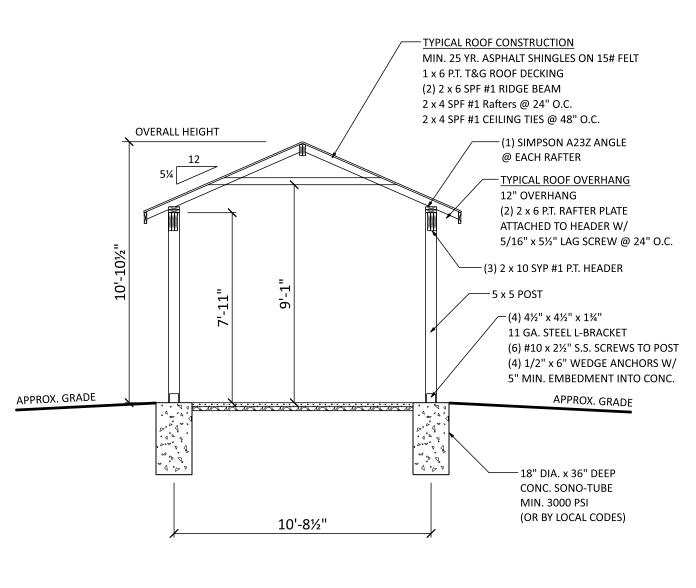

SECTION A SCALE: 1/4" = 1'-0"



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SCALE:

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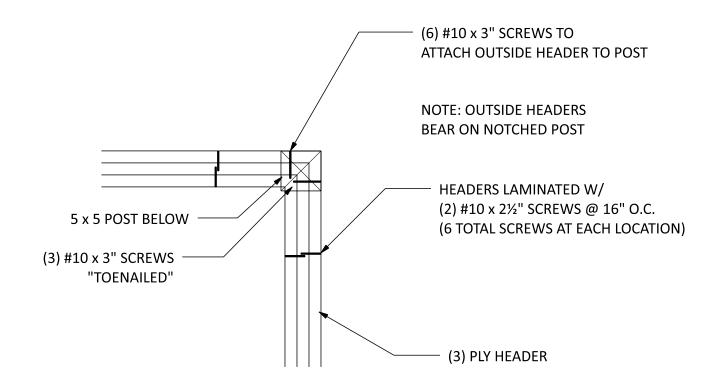
SHEET TITLE:

Section A

PROJECT NO.:

D851-21

3



HEADER TO POST

SCALE: 1" = 1'-0"



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SCALE:

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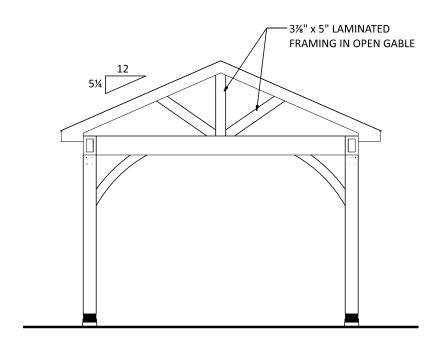
SHEET TITLE:

Header detail

PROJECT NO.:

D851-21

4



RIGHT ELEVATION

SCALE: 1/4" = 1'-0"

BUILDER:

Creative Gazenos

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SCALE:

AS NOTED

SHEET TITLE:

Right elevation

PROJECT NO.:

D851-21

5

FASTENER SCHEDULE FOR STRUCTURAL MEMBERS

| DESCRIPTION OF | BUILDING ELEMENTS | NUMBER AND TYPE OF FASTENER | SPACING OF FASTENERS | | |
|---|---|--------------------------------|--|--|--|
| | ROOF | | | | |
| CEILING JOISTS TO TOP PLATE | | (3) 10d | TOE NAIL | | |
| CEILING JOISTS NOT ATTACHED PARTITIONS | TO PARALLEL RAFTER, LAPS OVER | (4) 10d | FACE NAIL | | |
| COLLAR TIE TO RAFTER, FACE N | IAIL OR 1¼" X 20 GAGE RIDGE STRAP TO RAFTER | (4) 10d | FACE NAIL EACH RAFTER | | |
| RAFTER OR ROOF TRUSS TO PL | ATE | (3) 16d | TOE NAIL | | |
| ROOF RAFTERS TO RIDGE, VAL | LEY OR HIP RAFTERS | (4) 16d | TOE NAIL | | |
| | WALL | | | | |
| STUD TO STUD | | 16d | 24" O.C. FACE NAIL | | |
| BUILT-UP HEADER, TWO PIECES | 5 | 16d | 16" O.C. EA. EDGE FACE NAIL | | |
| CONTINUOUS HEADER TO STU | D | (4) 8d | TOE NAIL | | |
| DOUBLE STUDS, FACE NAIL | | 10d | 24" O.C. | | |
| TOP PLATE TO TOP PLATE | | 10d | 12" O.C. FACE NAIL | | |
| DOUBLE TOP PLATES, MINIMU FACE NAIL IN LAPPED AREA | M 48-INCH OFFSET OF END JOINTS, | (8) 16d | | | |
| BOTTOM PLATE TO JOIST, RIM | JOIST, BAND JOIST OR BLOCKING | 16d | 12" O.C. FACE NAIL | | |
| BOTTOM PLATE TO JOIST, RIM JOIST, | BAND JOIST OR BLOCKING (AT BRACED WALL PANEL) | (3) 16d | 16" O.C. FACE NAIL | | |
| TOP OR BOTTOM PLATE TO STU | OL | (3) 16d | END NAIL | | |
| TOP PLATES, LAPS AT CORNERS | AND INTERSECTIONS | (3) 10d | FACE NAIL | | |
| JOIST TO SILL, TOP PLATE OR G | IRDER | (4) 8d | TOE NAIL | | |
| RIM JOIST, BAND JOIST, OR BLOCKI | NG TO SILL OR TOP PLATE (ROOF APPLICATIONS ALSO) | 10d | 6" O.C. TO NAIL | | |
| BUILT-UP GIRDERS AND BEAMS | 5, 2-INCH LUMBER LAYERS | 10d | 24" O.C. FACE NAIL AT TOP AND BOTTOM STAGGERED ON OPPOSITE SIDES | | |
| WOOD STRUCTURAL PANELS, SUBFLOOR, ROOF AND INTERIOR WALL SHEATHING TO FRAMING AND PARTICLEBOARD WALL SHEATHING TO FRAMING | | | | | |
| \$\frac{5}{16}" - \frac{1}{2}" \qquad \text{6d COMMON NAIL (SUBFLOOR, WALL)} \\ 8d COMMON NAIL (ROOF) | | 6 | 12 | | |
| 19/32 " - 1" | 8d COMMON NAIL | 6 | 12 | | |
| ½" GYPSUM SHEATHING | $1\frac{1}{2}$ " GALVANIZED ROOFING NAIL; STAPLE GALVANIZED, $1\frac{1}{2}$ " LONG; $1-\frac{1}{6}$ " SCREWS, TYPE W OR S | 7 | 7 | | |
| 58 " GYPSUM SHEATHING | $1\frac{1}{4}$ " GALVANIZED ROOFING NAIL; STAPLE GALVANIZED, $1\frac{1}{8}$ " LONG; 1 $\frac{1}{8}$ " SCREWS, TYPE W OR S | 7 | 7 | | |

ALTERNATE ATTACHMENTS

| NOM. MATERIAL | DESCRIPTION OF FASTENER AND LENGTH | SPACING OF FASTENERS | | |
|--------------------------------------|--|----------------------|--------------------------------|--|
| THICKNESS (INCHES) | (INCHES) | EDGES (INCHES) | INTERMEDIATE SUPPORTS (INCHES) | |
| WOOD STRUCTURAL PANELS, SUBFLOOR, RO | OF AND INTERIOR WALL SHEATHING TO FRAMING AND PARTICLEBOARD WALL | SHEATHING TO FRAMING | | |
| | STAPLES 15 GA. 1 3/4 " | 4 | 8 | |
| UP TO 1/2" | NAIL 2 4" | 3 | 6 | |
| | STAPLES 16 GA. 1 3 " | 3 | 6 | |
| | STAPLES 14 GA. 2 | 4 | 8 | |
| 23 32 " AND 3 " | STAPLES 15 GA. 1 3/4 " | 3 | 6 | |
| | NAIL 2 1/4" | 4 | 8 | |

TABLE R602.3(3) REQUIREMENTS FOR WOOD STRUCTURAL PANEL WALL SHEATHING USED TO RESIST WIND PRESSURES

| MINIMUM | NAIL | MINIMUM | MINIMUM NOMINAL | MAXIMUM | PANEL NAIL | SPACING | MAXIMUM WIND SPEED (MPH) | | |
|--|--------------------------|--------------------|--------------------|------------------------|---------------|------------------------|-----------------------------|-----|----|
| SIZE PENETRATION STRUCTURAL PANEL SPAN (INCHES) RATING | STRUCTURAL PANEL SPAN | PANEL THICKNESS | THICKNESS SPACING | EDGES (INCHES O.C.) | FIELD | WIND EXPOSURE CATEGORY | | | |
| | (INCHES) | | (inches) | (inches) | (INCHES O.C.) | (INCHES O.C.) | В | С | D |
| 6d COMMON (2.0" X 0.113") | 1.5 | 24/0 | 3/8 | 16 | 6 | 12 | 110 | 90 | 85 |
| 8d COMMON | 1.75 | 24/16 | 7/16 | 16 | 6 | 12 | 130 | 110 | |
| (2.5" X 0.131") | 1.75 | 24/16 | 7/16 | 24 | 6 | 12 | 110 | 90 | 85 |

GENERAL NOTES

- ALL CONSTRUCTION SHALL COMPLY WITH 2015 INTERNATIONAL RESIDENTIAL CODE.
- BUILDER MUST VERIFY ALL DIMENSIONS AND ACCURACY BEFORE CONSTRUCTION.
- 3. WRITTEN DIMENSIONS SHALL TAKE PRECEDENCE OVER SCALED MEASUREMENTS.
- WINDOW AND DOOR, SIZES AND LOCATIONS, MAY VARY.
- 5. ALL STRUCTURAL LUMBER SHALL BE SPRUCE-PINE-FIR #2 OR BETTER, UNLESS OTHERWISE NOTED.
- ANY WOOD IN CONTACT WITH MASONRY TO BE PRESSURE-TREATED WOOD.
- 7. GRADE MUST SLOPE AWAY FROM STRUCTURE.



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General notes

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