

FRONT ELEVATION

SCALE: 1/4" = 1'-0"

CODE & LOADING INFORMATION

OCCUPANCY TYPE

- RESIDENTIAL STORAGE

CONSTRUCTION TYPE

- TYPE 5 B

LOADING NOTES

- 1st FLOOR ON GRADE

- GROUND SNOW = 30 PSF
- DEAD LOADS = 10 PSF
- BASIC WIND SPEED = 115 MPH
- EXPOSURE CLASS = B
- SEISMIC DESIGN CATEGORY = B
- FROST LINE DEPTH = 36" (OR BY LOCAL CODES)
- ASSUMED SOIL CLASS = GM, GC
- SOIL BEARING CAPACITY = 2000 PSF IF SOIL DIFFERS FROM ASSUMED ABOVE (REFER TO IRC CODES)



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PROJECT:

12x16 Keystone Pavilion Hip Style

FINAL	4/30/21	E.S.



DRAFTING

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SCALE:


AS NOTED


SHEET TITLE:

Cover sheet

PROJECT NO.:

D255-21

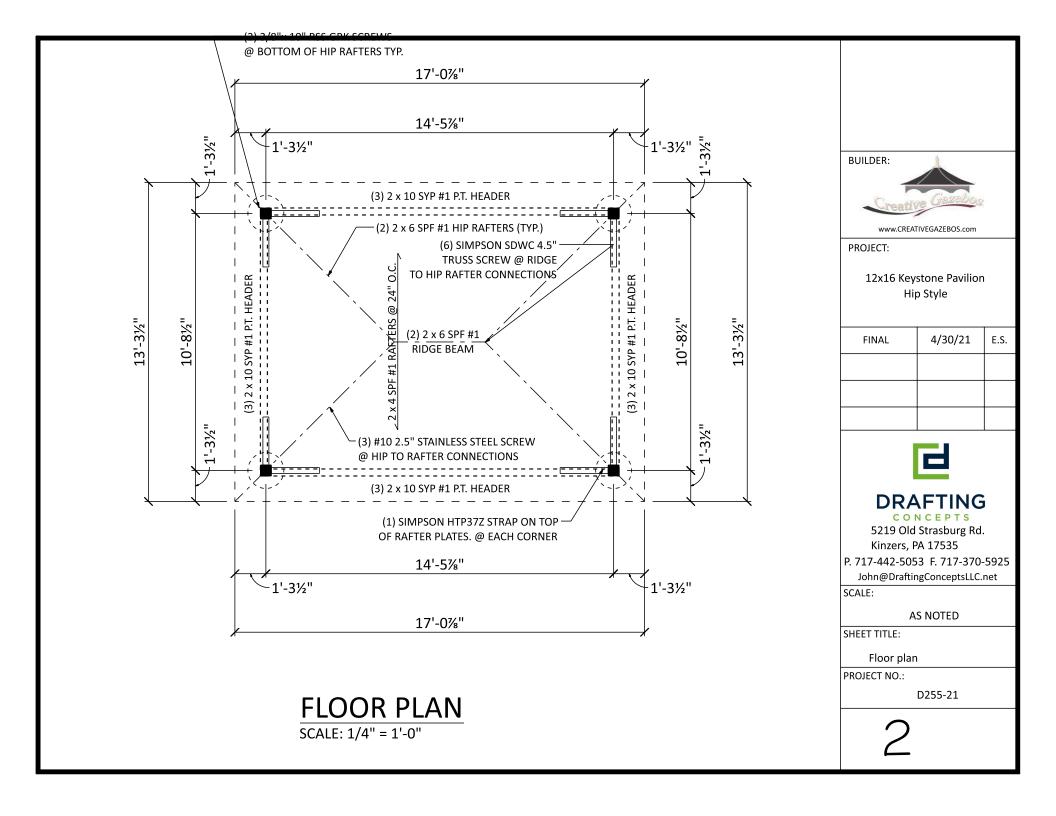

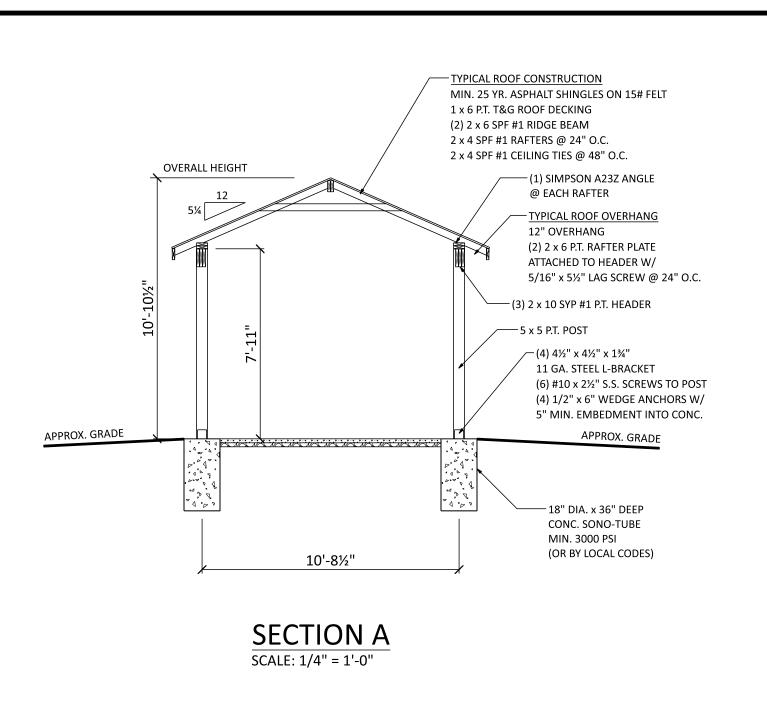



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SCALE:

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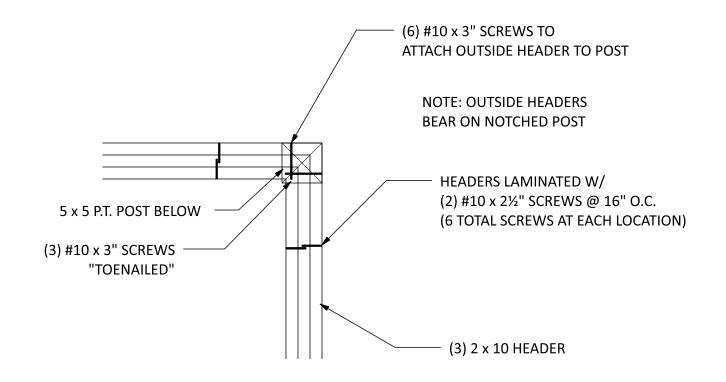
SHEET TITLE:

Section A

PROJECT NO.:

D255-21

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HEADER TO POST

SCALE: 1" = 1'-0"



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SCALE:

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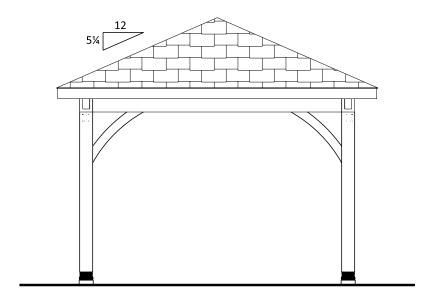
SHEET TITLE:

Connection detail

PROJECT NO.:

D255-21

4



RIGHT ELEVATION

SCALE: 1/4" = 1'-0"

BUILDER:



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SCALE:

AS NOTED

SHEET TITLE:

Right elevation

PROJECT NO.:

D255-21

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FASTENER SCHEDULE FOR STRUCTURAL MEMBERS

DESCRIPTION OF	BUILDING ELEMENTS	NUMBER AND TYPE OF FASTENER	SPACING OF FASTENERS			
ROOF						
CEILING JOISTS TO TOP PLATE		(3) 10d	TOE NAIL			
CEILING JOISTS NOT ATTACHED PARTITIONS	TO PARALLEL RAFTER, LAPS OVER	(4) 10d	FACE NAIL			
COLLAR TIE TO RAFTER, FACE N	IAIL OR 1¼" X 20 GAGE RIDGE STRAP TO RAFTER	(4) 10d	FACE NAIL EACH RAFTER			
RAFTER OR ROOF TRUSS TO PL	ATE	(3) 16d	TOE NAIL			
ROOF RAFTERS TO RIDGE, VAL	LEY OR HIP RAFTERS	(4) 16d	TOE NAIL			
	WALL					
STUD TO STUD		16d	24" O.C. FACE NAIL			
BUILT-UP HEADER, TWO PIECE	s	16d	16" O.C. EA. EDGE FACE NAIL			
CONTINUOUS HEADER TO STU	D	(4) 8d	TOE NAIL			
DOUBLE STUDS, FACE NAIL		10d	24" O.C.			
TOP PLATE TO TOP PLATE		10d	12" O.C. FACE NAIL			
DOUBLE TOP PLATES, MINIMU FACE NAIL IN LAPPED AREA	M 48-INCH OFFSET OF END JOINTS,	(8) 16d				
BOTTOM PLATE TO JOIST, RIM	JOIST, BAND JOIST OR BLOCKING	16d	12" O.C. FACE NAIL			
BOTTOM PLATE TO JOIST, RIM JOIST,	BAND JOIST OR BLOCKING (AT BRACED WALL PANEL)	(3) 16d	16" O.C. FACE NAIL			
TOP OR BOTTOM PLATE TO ST	סנ	(3) 16d	END NAIL			
TOP PLATES, LAPS AT CORNERS	AND INTERSECTIONS	(3) 10d	FACE NAIL			
JOIST TO SILL, TOP PLATE OR G	IRDER	(4) 8d	TOE NAIL			
RIM JOIST, BAND JOIST, OR BLOCKII	NG TO SILL OR TOP PLATE (ROOF APPLICATIONS ALSO)	10d	6" O.C. TO NAIL			
BUILT-UP GIRDERS AND BEAM:	5, 2-INCH LUMBER LAYERS	10d	24" O.C. FACE NAIL AT TOP AND BOTTOM STAGGERED ON OPPOSITE SIDES			
WOOD STRUCTURAL PANELS, SUBFLOOR, ROOF AND INTERIOR WALL SHEATHING TO FRAMING AND PARTICLEBOARD WALL SHEATHING TO FRAMING						
\$ 16 " - 2 " 6d COMMON NAIL (SUBFLOOR, WALL) 8d COMMON NAIL (ROOF)		6	12			
19 32 " - 1" 8d COMMON NAIL		6	12			
11 CALVANIZED ROPING NAIL: STAPLE GALVANIZED, 11 CALVANIZED ROPING NAIL: STAPLE GALVANIZED ROPING NAIL: STAPLE GALVAN		7	7			
5 " GYPSUM SHEATHING	$1\frac{3}{4}$ " GALVANIZED ROOFING NAIL; STAPLE GALVANIZED, $1\frac{5}{8}$ " SCREWS, TYPE W OR S	7	7			

ALTERNATE ATTACHMENTS

NOM. MATERIAL	DESCRIPTION OF FASTENER AND LENGTH	SPACING OF FASTENERS				
THICKNESS (INCHES)	(INCHES)	EDGES (INCHES)	INTERMEDIATE SUPPORTS (INCHES)			
WOOD STRUCTURAL PANELS, SUBFLOOR, ROOF AND INTERIOR WALL SHEATHING TO FRAMING AND PARTICLEBOARD WALL SHEATHING TO FRAMING						
	STAPLES 15 GA. 1 3 "	4	8			
UP TO ½"	NAIL 2 4"	3	6			
	STAPLES 16 GA. 1 3 "	3	6			
	STAPLES 14 GA. 2	4 8	8			
23 32 " AND 4"	STAPLES 15 GA. 1 3/4"	3	6			
	NAIL 2 4"	4	8			

TABLE R602.3(3) REQUIREMENTS FOR WOOD STRUCTURAL PANEL WALL SHEATHING USED TO RESIST WIND PRESSURES

МІМІМ	NAIL	MINIMUM WOOD	MINIMUM NOMINAL	MAXIMUM	PANEL NAIL SPACING		MAXIMUM WIND SPEED (MPH)		
SIZE	PENETRATION STR	ENETRATION STRUCTURAL PANEL PANEL SPAN THICKNESS	WALL STUD SPACING	NG EDGES	FIELD	WIND EXPOSURE CATEGORY			
0.00	(INCHES)			(inches)	(INCHES O.C.)	(INCHES O.C.)	В	С	D
6d COMMON (2.0" X 0.113")	1.5	24/0	3/8	16	6	12	110	90	85
8d COMMON	1.75	24/16	7/16	16	6	12	130	110	
(2.5" X 0.131")	1.75	24/16	//16	24	6	12	110	90	85

GENERAL NOTES

- ALL CONSTRUCTION SHALL COMPLY WITH 2015 INTERNATIONAL RESIDENTIAL CODE.
- 2. BUILDER MUST VERIFY ALL DIMENSIONS AND ACCURACY BEFORE CONSTRUCTION.
- 3. WRITTEN DIMENSIONS SHALL TAKE PRECEDENCE OVER SCALED MEASUREMENTS.
- 4. WINDOW AND DOOR, SIZES AND LOCATIONS, MAY
- 5. ALL STRUCTURAL LUMBER SHALL BE SPRUCE-PINE-FIR #2 OR BETTER, UNLESS OTHERWISE NOTED.
- 6. IF APPLICABLE, WHERE GARAGE IS ATTACHED TO DWELLING UNIT, A (1) HR. FIRE SEPERATION SHALL BE PROVIDED. (1 LAYER 1/2" DRYWALL). DOORS BETWEEN AREAS TO BE 20 MIN. C-LABEL DOOR WITH FIRE-CODE JAMB.
- ANY WOOD IN CONTACT WITH MASONRY TO BE PRESSURE-TREATED WOOD.
- 8. GRADE MUST SLOPE AWAY FROM STRUCTURE.



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General notes

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